

SITE VICINITY MAP





Clint Good ARCHITECTS, P.C.















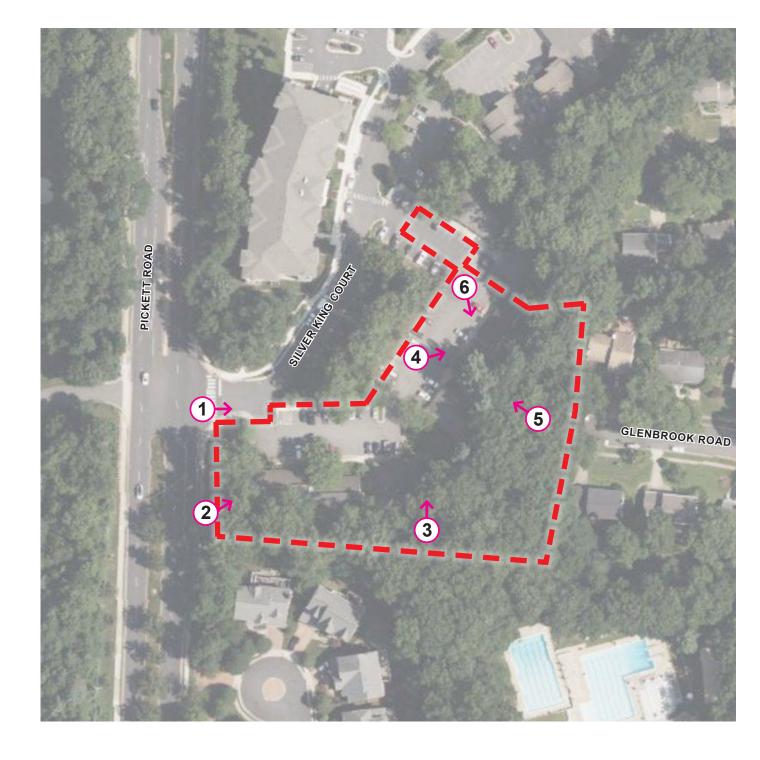

EXISTING CONDITIONS PHOTOS






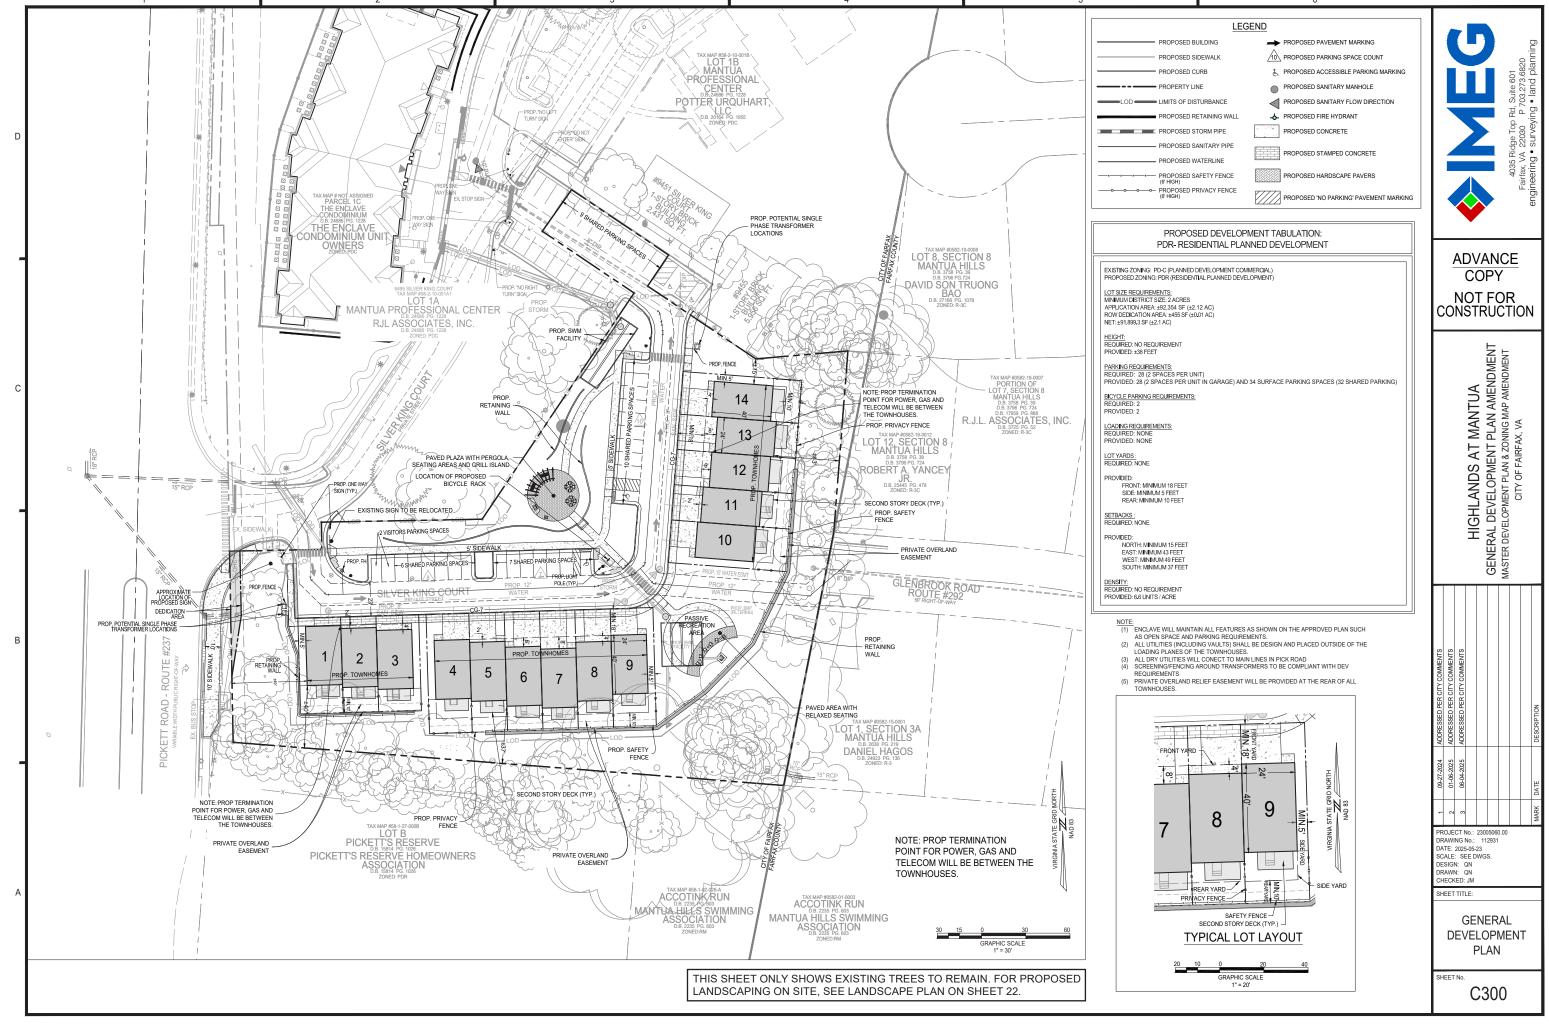








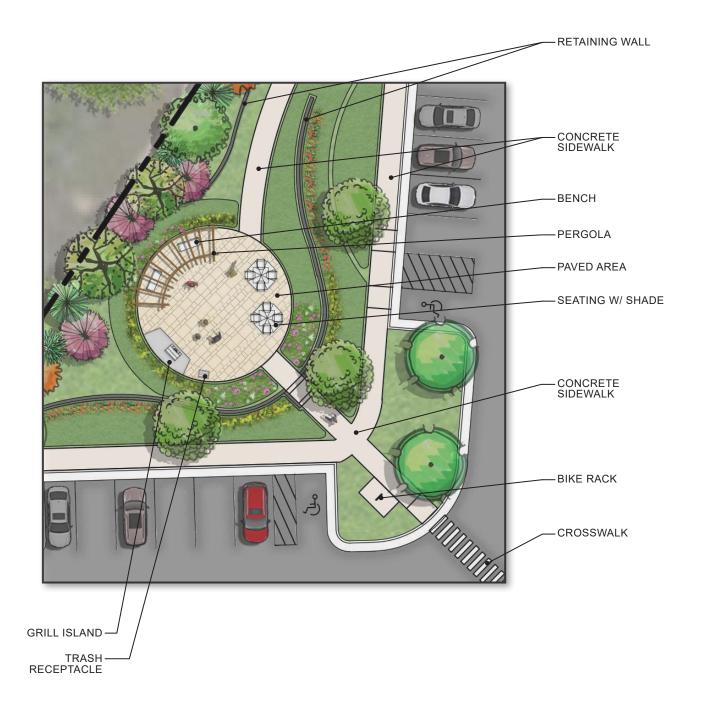

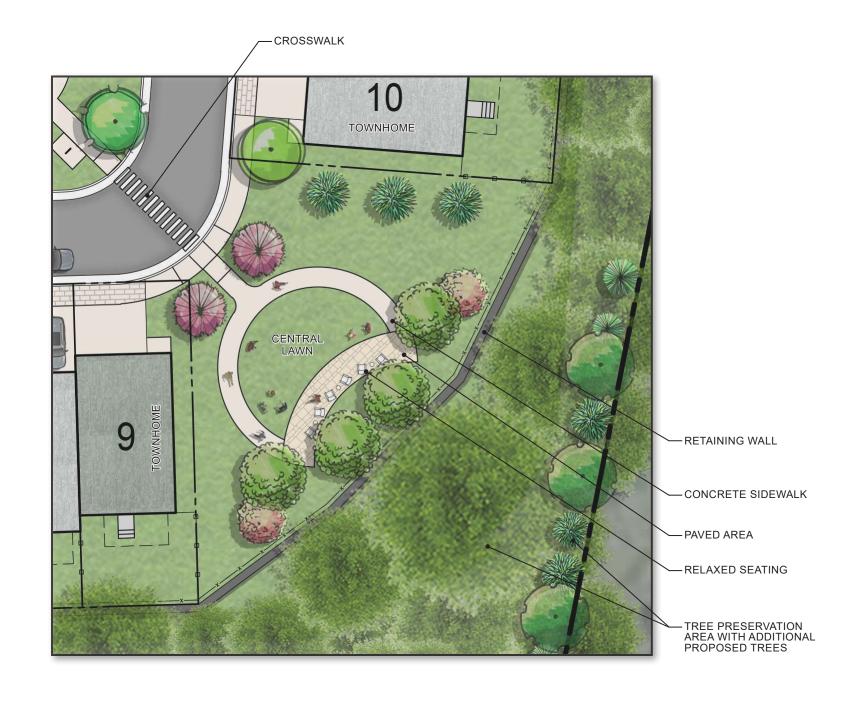

PLEASE NOTE: ANY INFORMATION SHOWN ON THIS PAGE IS FOR ILLUSTRATIVE PURPOSES ONLY, PROVIDED TO DESCRIBE THE GENERAL CONCEPT OF THE DESIGN. FINAL DESIGN WILL LIKELY VARY FROM WHAT IS SHOWN ABOVE.


RECREATIONAL AREA RENDERING










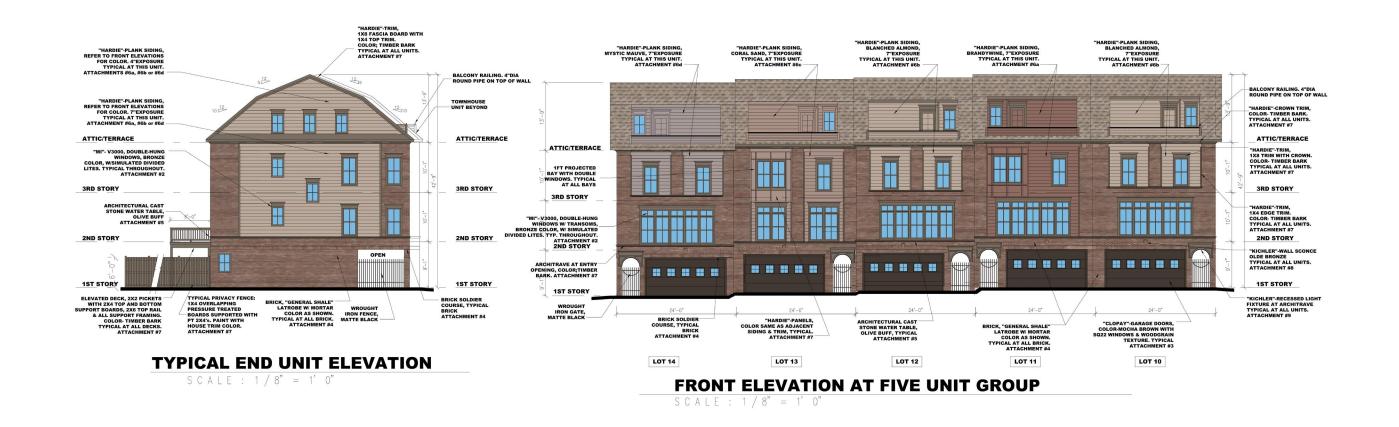

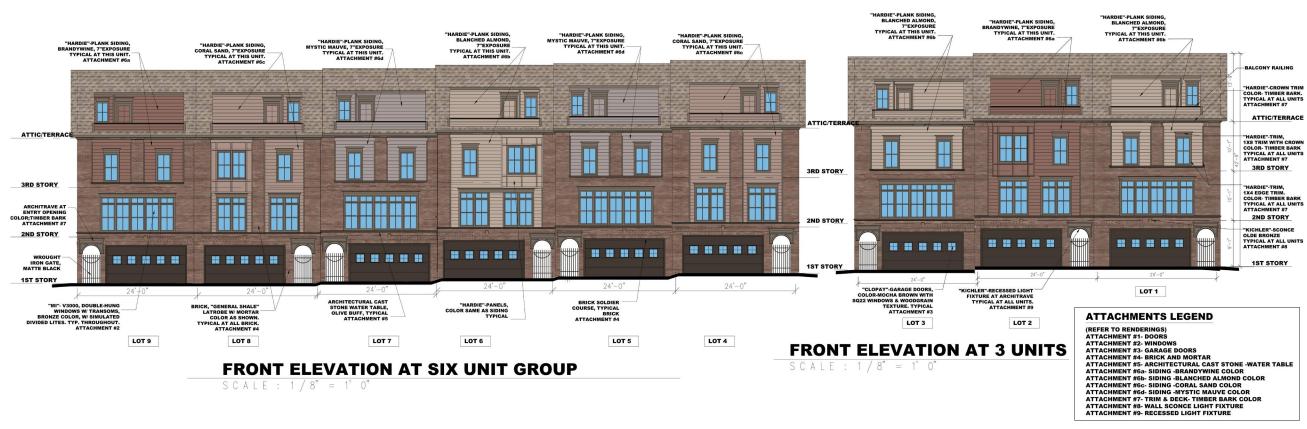

BUILDING ELEVATIONS










BUILDING ELEVATIONS





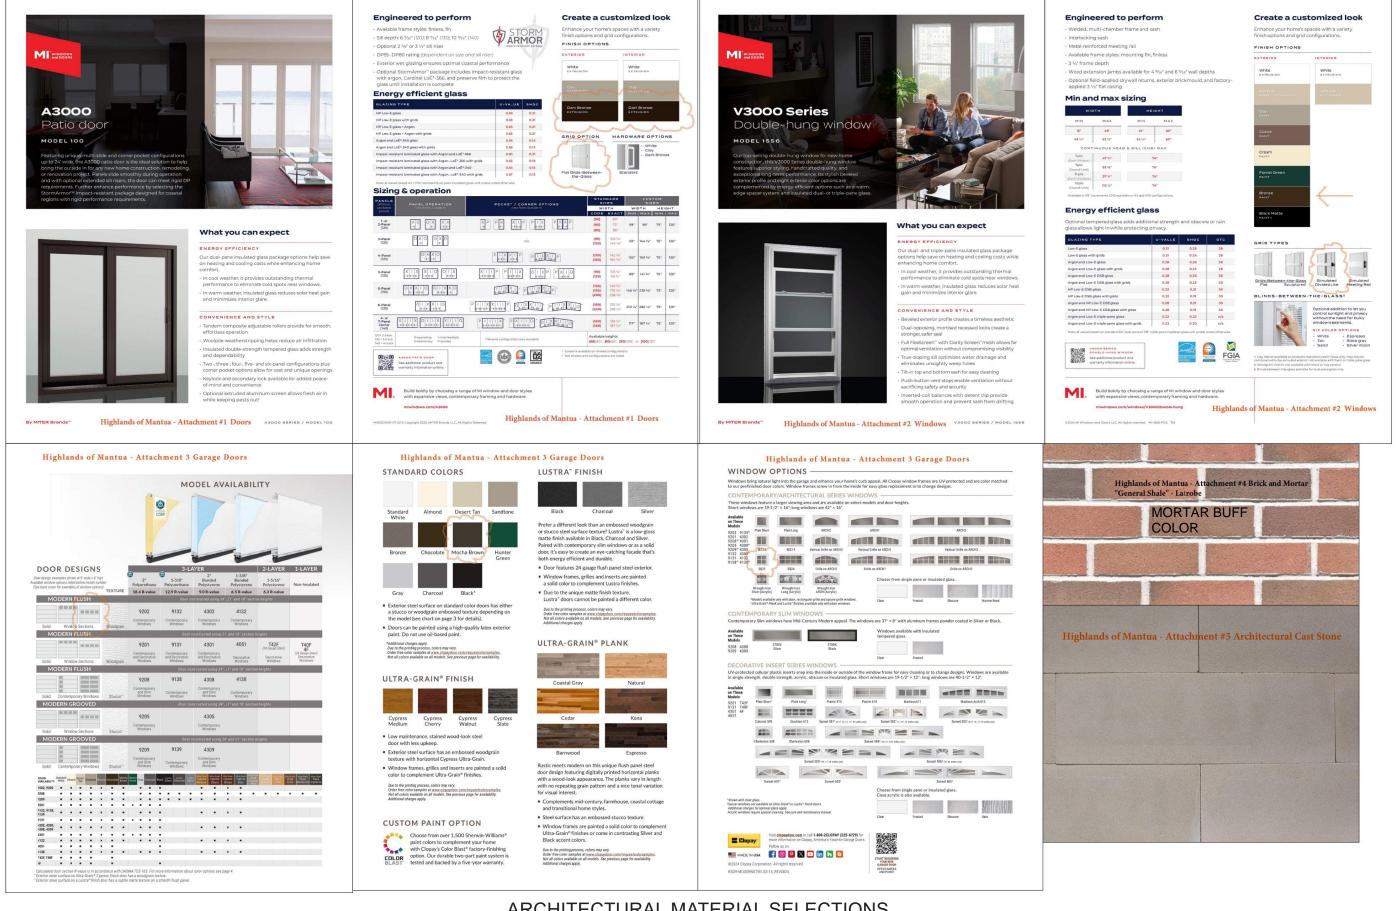


ARCHITECTURAL MATERIAL SELECTIONS








City of Fairfax, VA


Notes:

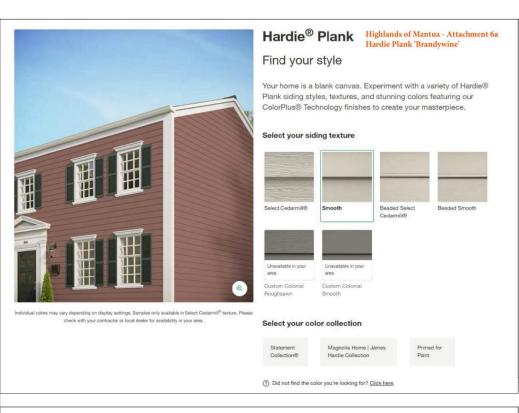


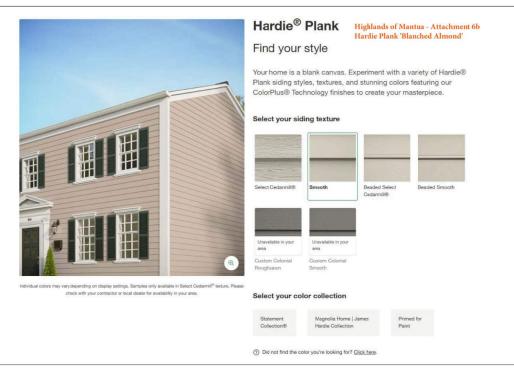

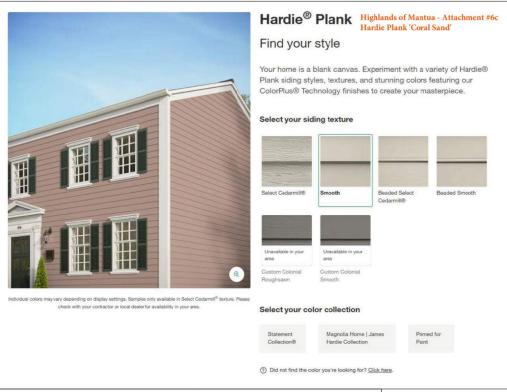

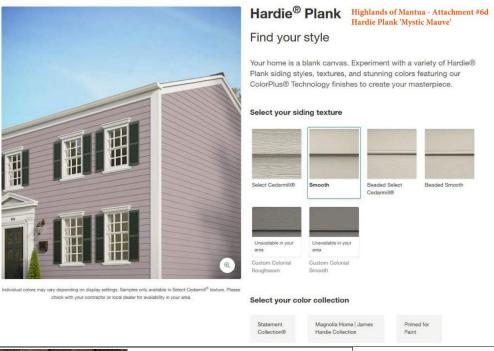

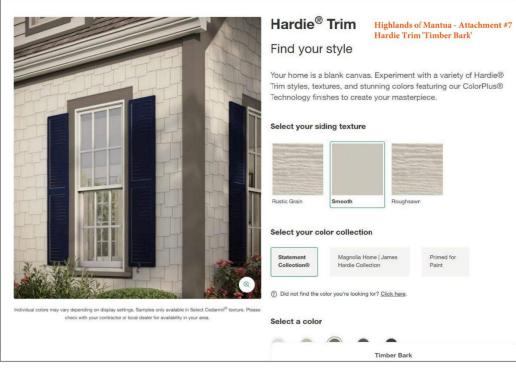

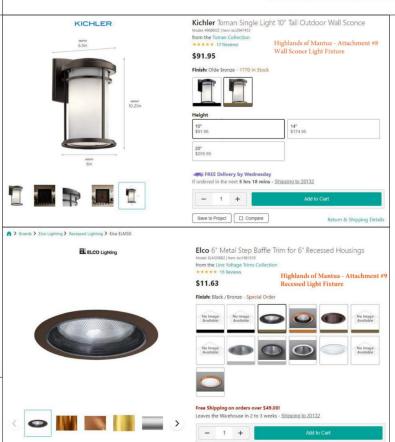



SHINGLES

MAKE: GAF


MODEL#: COLOR: TIMBERLINE HDZ


BARKWOOD


ARCHITECTURAL MATERIAL SELECTIONS





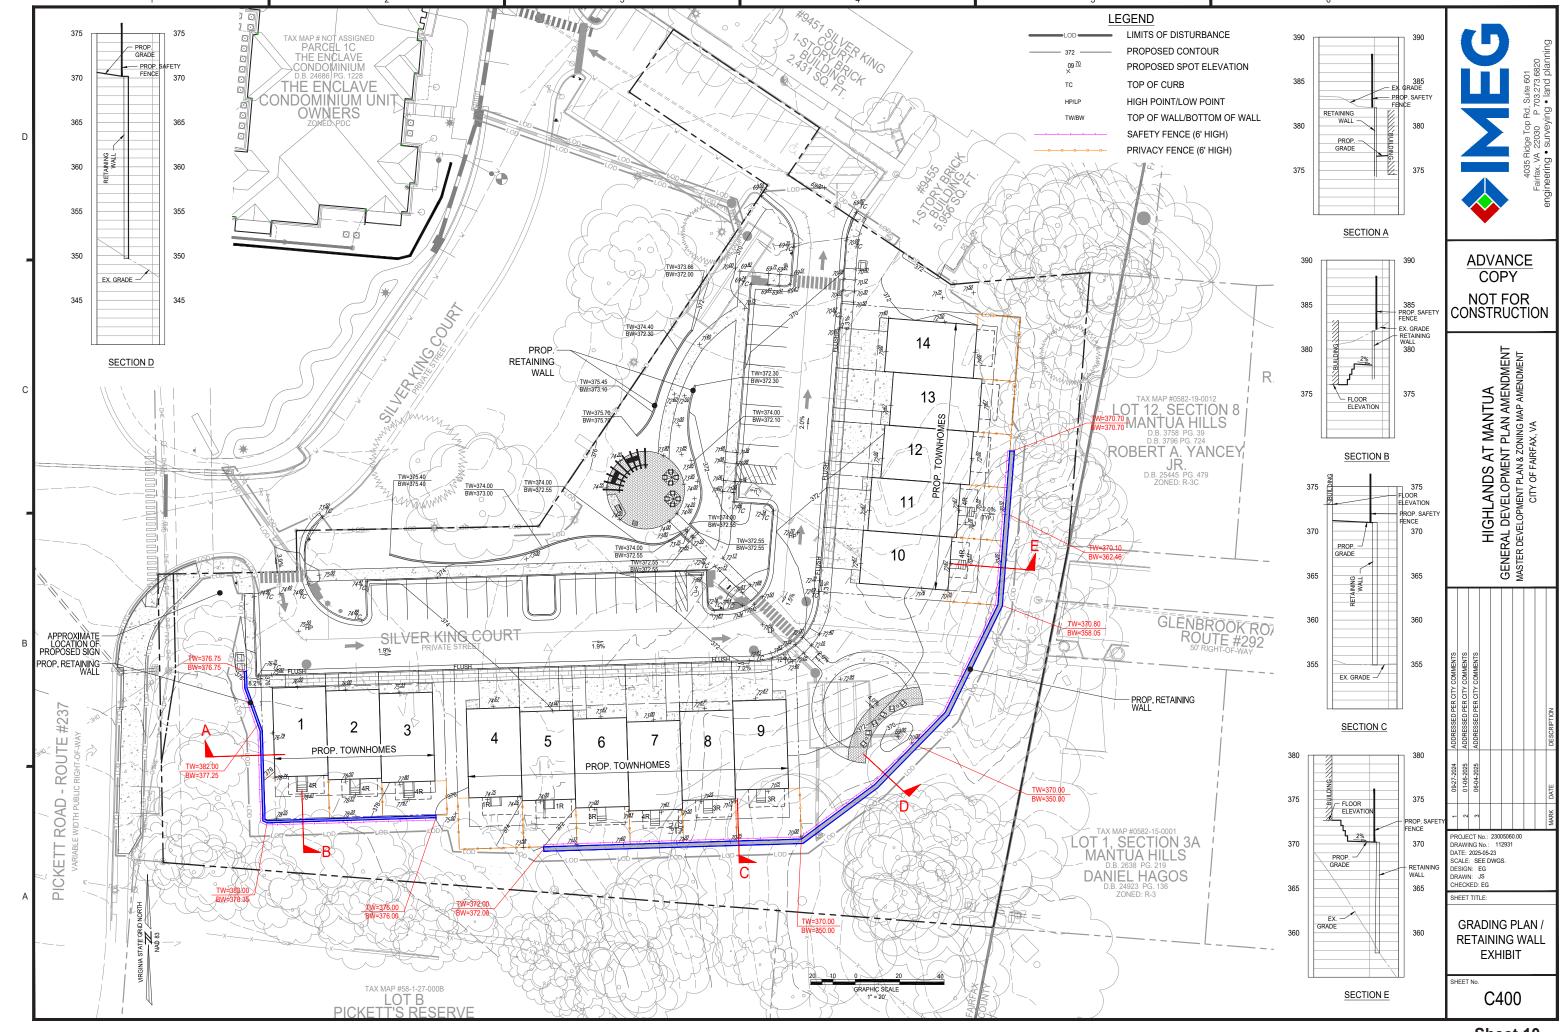

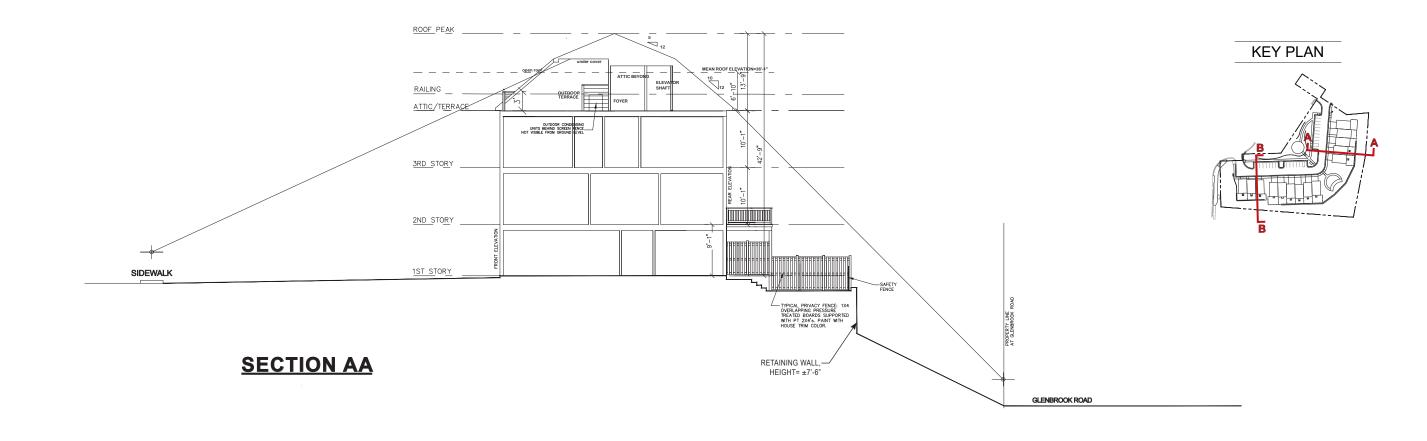

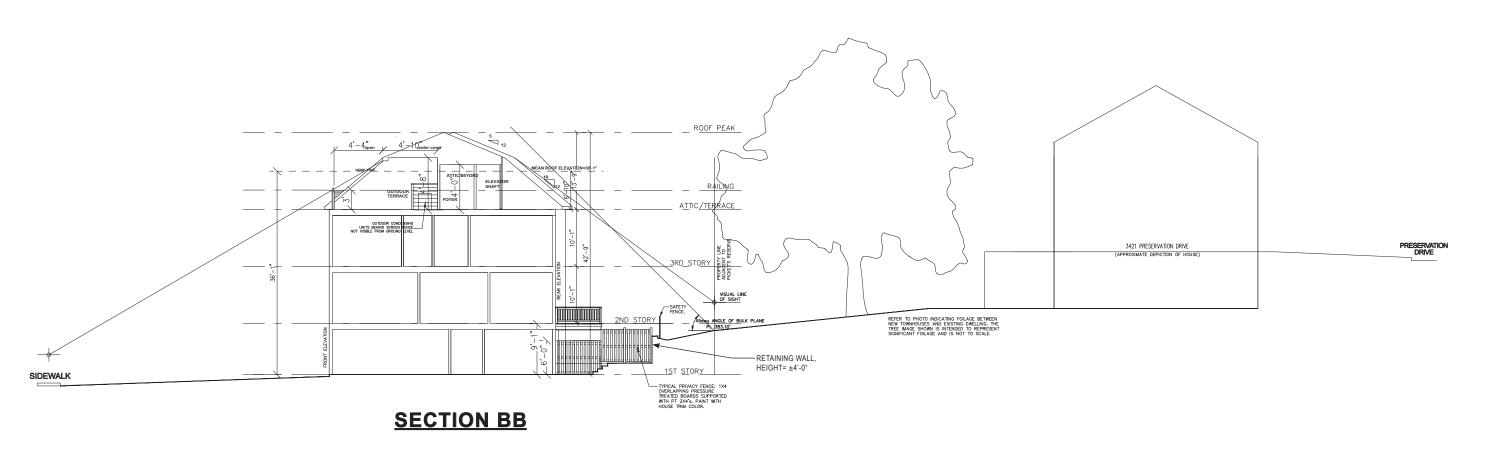

SIGHTLINE SECTION DIAGRAM










RENDERED PERSPECTIVE VIEW FROM THE ENCLAVE





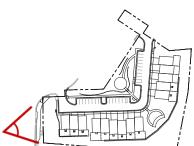



RENDERED PERSPECTIVE VIEW FROM PICKETT ROAD










RENDERED PERSPECTIVE VIEW OF 3 UNIT TOWNHOME (FRONT)





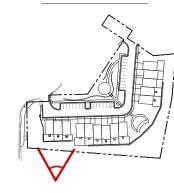




RENDERED PERSPECTIVE VIEW OF 3 UNIT TOWNHOME (REAR)





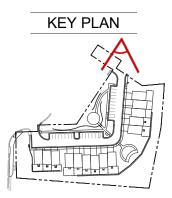



RENDERED PERSPECTIVE VIEW FROM THE NEW SCHOOL




















OVERALL RENDERED PERSPECTIVE VIEW OF THE DEVELOPMENT





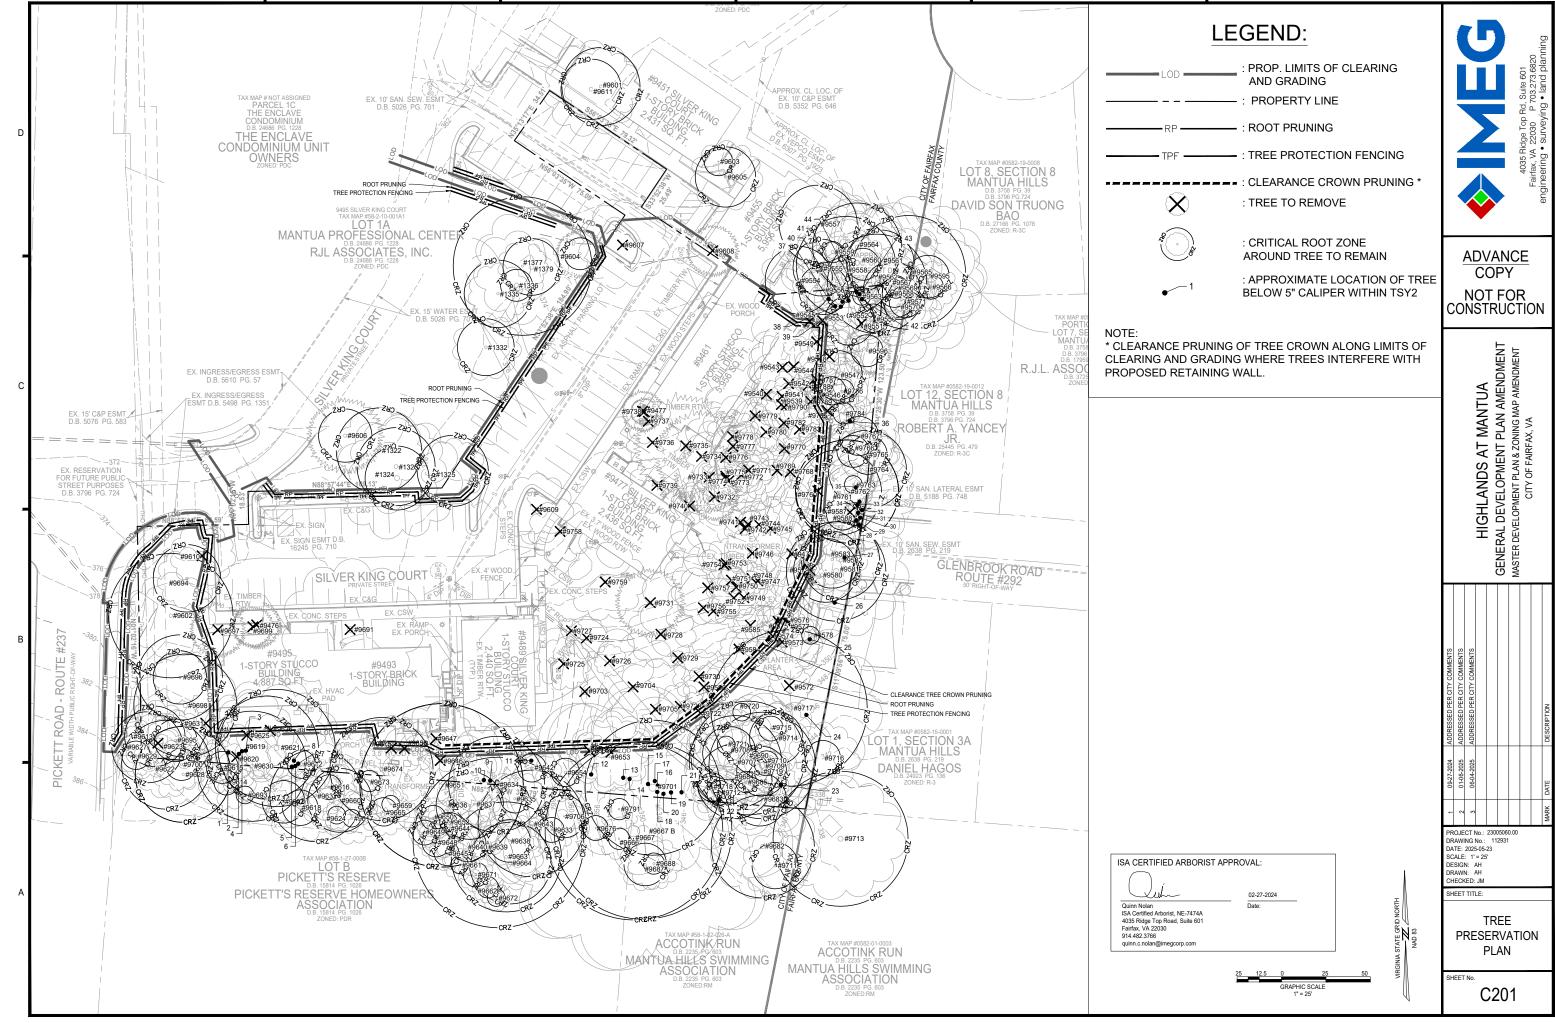


The column The									-									-	TREE	PRESERVATION SCHEDULE FOR TREES BELOW 5" CALIPER		
March 1985	REE PRESERVATI	ON SCHEDUI	LE							TRE	EE PRESERVAT	TION SCHEDUL	LE						TREI	E # BOTANICAL NAME COMMON NAME DIAMETER		A
Manufact Manufact	REE # BOTANICAL NAME	COMMON NAME	DIAMETE (INCHES) CRITICA ROOT ZOI RADIUS	ER SURV) / DRIF IL RAI NE (FE	PLINE DIUS		LOCATION	N PROCEDUR	E COMMENTS	TREE	# BOTANICAL NAME	COMMON NAME	DIAMETER (INCHES) / CRITICAL ROOT ZONE RADIUS	DRIPLINE RADIUS		LOCATION	PROCEDUR	E COMMENTS	1 2 3 4 5 6 7 8	ILEX OPACA	EC	
March Marc	1322 LIRIODENDRON TULIPIFERA	TULIP POPLAR	24	2	24	66	OFFSITE	REMAIN					5	15	72				10	ILEX OPACA AMERICAN HOLLY 1		3
March 1				2	27													SIGNIFICANT VINE GROWTH ON TRUNK. SOME DEAD SCAFFOLD BRANCHES.	12	ILEX OPACA AMERICAN HOLLY 3		
March Marc									PRUNED SCAFFOLD BRANCHES. LARGE HOLE/CAVITY IN TRUNK.					18			REMOVE		RE 14			
March Marc									LEADER DEAD; SIDE BRANCH HAS TAKEN LEADER POSITION. ROT VISIBLE IN										16			
March Marc													10 5	3 8				MOST BRANCHES DEAD ON ONE SIDE.	18 19			
WATER 1									STEM. LEANING, VERY UNEVEN CANOPY, BARK AND TRUNK IS CRACKING WITH WEIGHT			TULIP POPLAR	27	25	69		REMOVE		20	PRUNUS SEROTINA BLACK CHERRY 2		
March Marc														30	72	ONSITE			22			
March Marc	77 LIRIODENDRON TULIPIFERA	TULIP POPLAR	39	1	14	66	OFFSITE	REMAIN	GIRDLING ROOT VISIBLE.				20	18	66			AND DROP.	_			
Company Comp									BRANCHES. LARGE FUNGAL FRUITING BODY GROWING ON TRUNK.	9629	ACER RUBRUM	RED MAPLE	8	2	72	OFFSITE	REMAIN			ELOWERING DOGWOOD	·	
Marche M	76 JUNIPERUS VIRGINIANA	EASTERN REDCEDAR	6		9	66	ONSITE	REMOVE		9631	UNIDENTIFIED	DEAD TREE	10	7	25	ONSITE	REMOVE		27	BLACK LOCUST		
Company										9633	FAGUS GRANDFOLIA	AMERICAN BEECH	7	20	69	OFFSITE	REMAIN	OLD WOUND AT BASE OF TRUNK. DECAY IN HEARTWOOD EXPOSED BY WOUND.	28		AD\	/AN
March Marc	40 QUERCUS MONTANA	CHESTNUT OAK	9	3	35	63	ONSITE	REMOVE		9635	ACER RUBRUM	RED MAPLE				OFFSITE	REMAIN		29	ROBINIA PSEUDOACACIA BLACK LOCUST 1		
Marche	11 PINUS VIRGINIANA	VIRGINIA PINE	12	1	18	56	ONSITE	REMOVE										DEAD TREE.	30	ROBINIA PSEUDOACACIA BLACK LOCUST 1		
The content	2 FAGUS GRANDFOLIA				_				SMALL WOUND IN TRUNK.	9638	ACER RUBRUM	RED MAPLE	12	16	69	OFFSITE	REMAIN		31	ROBINIA PSEUDOACACIA BLACK LOCUST 1		
Part	4 FAGUS GRANDFOLIA	AMERICAN BEECH	11	2	25	69	ONSITE	REMOVE												ROBINIA PSEUDOACACIA 1	CONST	KU(
March Marc	ROBINIA PSEUDOACACIA	BLACK LOCUST	8	1	12	75	ONSITE	REMOVE		9641	UNIDENTIFIED	DEAD TREE	20	2 16		ONSITE			33			
Mile	LIRIODENDRON TULIPIFERA	TULIP POPLAR	24	1	17	75	ONSITE	REMOVE	CONKS ON SOME BRANCHES.	9643	LIRIODENDRON TULIPIFERA	TULIP POPLAR		31		OFFSITE	REMAIN		34	ROBINIA PSEUDOACACIA 2		Ŀ
Mile	FAGUS GRANDFOLIA								TOP PREVIOUSLY BROKEN FROM STORM. REMAINING CANOPY GREW AT 90	9645	ILEX OPACA	AMERICAN HOLLY	7	10	72	OFFSITE	REMAIN	ELINICAL EPHITING BODY GROWING AT PACE OF POOT FLADS LARGE CO.	35	ROBINIA PSEUDOACACIA 1		EN
Mile									DEGREES.	9646		BLACK CHERRY	20	33	69	ONSITE	REMOVE	BRANCH OVERHANGING EXISTING BUILDING.	37	FAGUS GRANDFOLIA AMERICAN BEECH 3		M
Mile	FAGUS GRANDFOLIA	AMERICAN BEECH	14			72	ONSITE	REMAIN					19	20	69				39	ILEX OPACA AMERICAN HOLLY 3	⊴	, E
Mile	FAGUS GRANDFOLIA			2	22				SOIL AROUND ROOTS IS HIGHLY ERODED. CO-DOMINANT CANOPY STRUCTURE.				7	10 9	75 72				41	FAGUS GRANDFOLIA AMERICAN BEECH 4		' \ ₩
Mile	FAGUS GRANDFOLIA	AMERICAN BEECH	16	2	20	69	OFFSITE	REMAIN					7 46	11 32						ILEX OPACA AMERICAN HOLLY 3	Ż	. Ż
March Marc										9652	ROBINIA PSEUDOACACIA	BLACK LOCUST						GROWING AT AN ANGLE. CAVITY IN TRUNK (SMALL). TAGGED WITH TWO TAGS	- '		₩	. ₫
Section Process Proc						72													_			
Management Man										9655	BETULA LENTA	BLACK BIRCH	7	12	75	ONSITE	REMOVE	OLD WOUND LIFELING OVER AT DACE OF TRUMY				111
Part	LIRIODENDRON TULIPIFERA	TULIP POPLAR	19	3	33	69	OFFSITE	REMAIN	OLD WOUNDS HEALING OVER ON ROOT FLARE AND TRUNK.	9659	ROBINIA PSEUDOACACIA	BLACK LOCUST	5		72	OFFSITE	REMAIN	OLD WOUND HEALING OVER AT BASE OF TRUNK.				ה נ
Part					_								18	20	75			OLD CABLE STUCK IN BRANCH UNION. TREE BEGINNING TO GROW AROUND OLD)		Z	, ō
The content									SMALL BEECH TREE RUBBING ON LOWER TRUNK.				6	9	75			CABLE.				i W
Proceedings	FAGUS GRANDFOLIA		7	1	14	69	OFFSITE				EMIODENDION TOES IL ENA			20 23	72 69				-		T	
Proceedings	FAGUS GRANDFOLIA		9	1	12	75	OFFSITE						8	14 12	72 69			LEADER BROKEN OUT.	-		Ī	: 4
Control Cont	FAGUS GRANDFOLIA	AMERICAN BEECH	8	2	23	69	OFFSITE	REMAIN	SOIL HIGHLY ERODED AROUND ROOT FLARE.	9667	LIRIODENDRON TULIPIFERA	TULIP POPLAR	50	80	69	OFFSITE	REMAIN					5
Company Comp										9667 B	LIRIODENDRON TULIPIFERA	TULIP POPLAR	50	80	69	OFFSITE	REMAIN	SOME GIRDLING ROOTS. TRUNK DISPLAY SURFACE INSECT DAMAGE. SOME				Z
Company																						G
MANUAL PRINTING 1			33 5	2	9	75 72				9673	SASSAFRAS ALBIDUM	SASSAFRAS	6	9	69	OFFSITE	REMAIN	CLE CHOLE ANGOIN THEE THE DEGINNING TO GROW ANGOIN CLE CHOLE.				П
March Marc	ILEX OPACA								GROWING OUT OF SAME POINT AS TREE 9577. TREE 9577'S BRANCHES ARE	9675	PRUNUS VIRGINIANA	CHOKE CHERRY	9			ONSITE	REMOVE	ADJACENT CHOKE CHERRY IS RUBBING AGAINST TRUNK.				
March Marc								+	RUBBING TRUNK OF TREE 9576.	9682	ACER RUBRUM	RED MAPLE		30	72	OFFSITE	REMAIN	HIGH NUMBER OF EPICORMIC SPROUTS GROWING ON TRUNK.				
MANISONS DATES 19			7							9684	LIRIODENDRON TULIPIFERA	TULIP POPLAR		30 29	69 72	ONSITE	REMAIN					
			17	1	7					9687	FAGUS GRANDFOLIA	AMERICAN BEECH	6 12	12 15	72 75	OFFSITE	REMAIN	SOIL AROUND ROOTS IS HIGHLY ERODED.			12 IS	
Secretary Company Comp		TULIP POPLAR			9	75	OFFSITE		ON ROOT FLARE.				6 32	15 35	75 69			LARGE SCAFFOLD BRANCH BROKEN DUE TO STORM DAMAGE.			AMEN AMEN	
									TIP DIEBACK ON LEADER OVERHANGING NEIGHBORING HOUSE.					39 12	69 72			LARGE GIRDLING ROOT. LEANING OVER PARKING LOT.	-		CON	
Math	LIRIODENDRON TULIPIFERA ILEX OPACA									9693	PRUNUS SEROTINA								_		R CIT	
MORROSPORT MARCH MARCH MORROSPORT MARCH MARCH MORROSPORT MARCH MARCH					0	69			MULTIPLE TRUNKS, SOME MINOR INCLUDED BARK.										-		9 0 D	
MACCO GAMESTON MACCO MATERIAL STATE STAT	UNIDENTIFIED		9			25	ONSITE		SEVERE LEAN CROWN HAS PREVIOUSLY RROKEN OR TWISTED IN STORM												RESSE	
Company Comp										9698	LIRIODENDRON TULIPIFERA	TULIP POPLAR		29	75	ONSITE	REMAIN				ADDF ADDF	
AURICAN RECK 12 2 2 2 5 9 0 19 1 10 19 19										9700	FAGUS GRANDFOLIA	AMERICAN BEECH		15	75	OFFSITE	REMAIN					П
MALIS SPP. CREATING SAMPLE S S S A CFSTT SAMPLE SAMPLE	FAGUS GRANDFOLIA	AMERICAN BEECH	22	2	21	59	OFFSITE	REMAIN										DUAL TRUNKS. SEVERE INCLUDED BARK.	1		7-2024 2025 2025	
AUGUS SPR COMMPTE B B 3B OFFITE REMAN AUGUS COMMETTING AND CONTINUES A	LIRIODENDRON TULIPIFERA	TULIP POPLAR	35	2	24	72	ONSITE	REMAIN	BROWN. LEAVES BEGINNING TO CHANGE COLOR AND DROP.	9704	LIRIODENDRON TULIPIFERA	TULIP POPLAR	37	30	69	ONSITE	REMOVE	ON/NEAR ROOTS.	4		09-27 01-06 06-04	
					8				ALMOST COMPLETELY DEAD. TRUNK IS TWISTED AND CRACKED AND IS MISSING				30	28	66			LEADER BROKEN OUT.			+++	\vdash
MAILES PP 17 20 44 OFFSTE REMAIN ALMOST OMERS ON IT, TWO MAJOR BRANCH STEAM ORGANDS AND LOAD AND MASS OFFSTE MAILES PP ALMOST OFFSTE MAJOR OFFSTE MAJ									ROOTS DAMAGED BY LOCATION OF TRAIL AND PLANTER BOXES.	9707	LIRIODENDRON TULIPIFERA	TULIP POPLAR	12 26	10 29	72 72	ONSITE	REMAIN	GIRDLING ROOTS.	\exists		- 2 6	
CARBAPPE 17 20 44 OFFSIT SEAM CARBOT TO SARC OF IT. VOM ADDR BRANCHS SED AN COT J. DAMAGED BY CARBOT TO SARC OF IT. VOM ADDR BRANCHS SED AN COT IT. VOM ADDR BRANCHS SED AND COT IT. SED AND COT IT. VOM ADDR BRANCHS SED AND	PINUS NIGRA	AUSTRIAN PINE	9	1	14	63	OFFSITE	REMAIN	TURNING BROWN. FOUR SMALL DEAD STUBS.					25 40				SIGNIFICANT VINE GROWTH ON TRUNK.	-		DDO IECT No :	230050
STUDIA CAMADENSIS EASTERN HEMLICOX 15 22 66 OFFSITE REMAIN LOCATION OF INDIA RADIJUNINE ROSS.	MALUS SPP.	CRABAPPLE	17	2	20	44	OFFSITE	REMAIN	ALMOST NO BARK ON IT. TWO MAJOR BRANCHES DEAD, ROOTS DAMAGED BY				<u> </u>					TOP HALF OF TREE IS DEAD. EPICORMIC SPROUTING ON TRUNK.	-		DRAWING No.:	11293
PRING CALERY FRAR 15 25 38 ONSITE REMOVE COMPLETELY DATE OF STORM OF THE PRING OF THE PRINC OF TH	TSLIGA CANADENSIS	EASTERNI HEMILOCK	15		22	66	OFFSITE	DEMAIN		9712	ACER RUBRUM		7								SCALE: NOT T	TO SCA
CHECKED AND 13 25 38 CHECKED AND 14 15 59 CHECKED AND 14 15 59 CHECKED AND 14 15 59 CHECKED AND 15 CHECKED A									DEAD. POOR PRUNING CUT HEALING OVER.												DRAWN: AH, C	QN
School Column C							+		COMPLETELY DEAD, GIRDLING ROOTS.			AMERICAN HOLLY	7	9	75			DROVEN DRANCH AND HANCED IN CROWN DIE TO TOO SPOAL NEIGHTSTON	1			
UET O BRANCH ERMOVALS. 13 18 66 ONSITE REMOVE DUE TO BRANCH ERMOVALS.							+		DEAD MID-SIZE BRANCHES.						69						SHEET TITLE:	
ACER RUBRIUM RED MAPLE 9 15 72 0.0 FISTE REMAIN REDMAPLE 9 15 72 0.0 FISTE REMAIN SIGNIFICANT VINE GROWTH ON TRUNK AND IN CANOPY. 9729 MERCHANNO SIGNIFICANT VINE GROWTH ON TRUNK AND IN CANOPY. 9720 MERCHANNO SIGNIFICANT VINE GROWTH ON TRUNK AND IN CANOPY. 9721 MERCHANNO SIGNIFICANT VINE GROWTH ON TRUNK AND IN CANOPY. 9721 MERCHANNO SIGNIFICANT VINE GROWTH ON TRUNK AND IN CANOPY. 9721 MERCHANNO SIGNIFICANT VINE GROWTH ON TRUNK AND IN CANOPY. 9722 MEX OPACA AMERICAN HOLLY 7 13 72 0.0 SITE REMOVE 9721 MERCHANNO SIGNIFICANT VINE GROWTH ON TRUNK AND IN CANOPY. 9722 MEX OPACA AMERICAN HOLLY 7 13 72 0.0 SITE REMOVE 9721 MERCHANNO SIGNIFICANT VINE GROWTH ON TRUNK AND IN CANOPY. 9722 MEX OPACA AMERICAN HOLLY 7 13 72 0.0 SITE REMOVE 9723 MERCHANNO SITE REMOVE 9724 MERCHANNO SITE REMOVE 9725 MERCHANNO SITE MER	MALUS SPP.	CRABAPPLE	29	2	20	63	ONSITE	REMOVE	DUE TO BRANCH REMOVALS.				8	50 12	72 72				∃ г.	SA CERTIFIED APPODIST APPROVAL.	١ ,	грг
ACER RUBRUM RED MAPLE 8 20 66 ONSITE REMAIN SIGNIFICANT VINE GROWTH ON TRUNK AND IN CANOPY.	ILEX OPACA	AMERICAN HOLLY	13	1	18	66	ONSITE	REMOVE	PRUNING WOUND HEALING OVER WITH ROT PRESENT IN HEARTWOOD.				14	10	59				_ '	OA OLITIFIED ANDURIOT APPROVAL:		
ACER RUBRIUM RED MAPLE 8 20 66 ONSITE REMAIN SIGNIFICANT YINE GROWTH ON TRUNK AND IN CANOPY.	LIRIODENDRON TULIPIFERA	TULIP POPLAR	17	2	27	69	OFFSITE	REMAIN					5	8 12	72 66				_	(), i		
PRUNUS SEROTINA BLACK CHERRY 7 16 72 OFFSITE REMAIN 972.4 FRASTULA LENTA GREEN ASH 6 12 69 ONSITE REMOVE TWO TRUNKS. GRAPE VINKS. IN CANOPY. ISA Certified Arborist, NE-7474A SHEET No. ACER RUBRUM RED MAPLE 9 15 72 OFFSITE REMAIN BLACK LIENTA			8 17	_		66 69			SIGNIFICANT VINE GROWTH ON TRUNK AND IN CANOPY.	9722	ILEX OPACA	AMERICAN HOLLY	7			ONSITE	REMOVE		-		IABL	/LA
ACER RUBRUM RED MAPLE 7 14 72 OFFSITE REMAIN MANY VINES IN CANOPY. 9726 LIRIODENDRON TULIPIFERA TULIP POPLAR 6 9 72 ONSITE REMOVE Failfax, VA 22030 ROBINIA PSEUDOACACIA BLACK LOCUST 5 15 72 OFFSITE REMAIN SMALL SECONDARY TRUNK DEAD. 9727 ILEX OPACA AMERICAN HOLLY 6 6 69 ONSITE REMOVE GROWING OVER TOP OF CONCRETE CULVERT. INCLUDED BARK BETWEEN 914.482.3766	PRUNUS SEROTINA	BLACK CHERRY	7	1	16	72	OFFSITE	REMAIN	1	9724	FRAXINUS PENNSYLVANICA	GREEN ASH		12	69	ONSITE	REMOVE	TWO TRUNKS. GRAPE VINES IN CANOPY.		ISA Certified Arborist, NE-7474A	SHEET No	—
ROBINIA PSEUDOACACIA BLACK LOCUST 10 20 72 OFFSITE REMAIN UNEVEN CANOPY, DEAD BRANCHES IN CANOPY. REMOVE SERVING UNITE SEMAIN SMALL SECUNDARY IRUNK UEAD. 9727 LEX OPACA AMERICAN HOLLY 6 6 6 69 ONSITE REMOVE TRUNKS. 9727 REMOVE 10 0 0 0 0 0 0 0 0 0 0 0 0 0 0 0 0 0	ACER RUBRUM	RED MAPLE	7	1	14	72	OFFSITE	REMAIN		9726	LIRIODENDRON TULIPIFERA	TULIP POPLAR	6	9	72	ONSITE	REMOVE			Fairfax, VA 22030		10 0
										9727	ILEX OPACA	AMERICAN HOLLY	6	6	69	ONSITE	REMOVE					∪∠ر

TREE PRESERVATION SCHEDULE

		BOTANICAL NAME	COMMON NAME	TRUNK DIAMETER (INCHES) / CRITICAL ROOT ZONE RADIUS (FEET)	SURVEYED DRIPLINE RADIUS (FEET)	CONDITION RATING	LOCATION	PROCEDURE	
- 1		LIRIODENDRON TULIPIFERA	TULIP POPLAR	13	19	72	ONSITE	REMOVE	SIGNIFICANT ENGLISH IVY ON TRUNK.
		UNIDENTIFIED	DEAD TREE	14	4	25	ONSITE	REMOVE	DEAD TREE.
D	9730	LIRIODENDRON TULIPIFERA	TULIP POPLAR	14	15	75	ONSITE	REMOVE	
٠.	9731	PINUS STROBUS	WHITE PINE	24	20	75	ONSITE	REMOVE	
		PINUS STROBUS	WHITE PINE	11	14	72	ONSITE	REMOVE	
		PINUS STROBUS	WHITE PINE	21	20	69	ONSITE	REMOVE	
		PINUS STROBUS	WHITE PINE	22	27	69	ONSITE	REMOVE	
	9735	PINUS STROBUS	WHITE PINE	25	30	72	ONSITE	REMOVE	
	9736	CORNUS FLORIDA	FLOWERING DOGWOOD	7	15	59	ONSITE	REMOVE	DECAY IN BOTH TRUNKS. BARK IS SLOUGHING OFF, EXPOSING HEARTWOOD. APPROXIMATELY 1/3 OF CANOPY IS DEAD.
	9737	CORNUS FLORIDA	FLOWERING DOGWOOD	9	13	66	ONSITE	REMOVE	LEAVES INDICATE THAT TREE IS SUFFERING FROM FUNGAL DISEASE.
	9738	UNIDENTIFIED	DEAD TREE	7	8	25	ONSITE	REMOVE	TREE IS DEAD.
	9739	CORNUS KOUSA	KOUSA DOGWOOD	7	16	72	ONSITE	REMOVE	
	9740	CORNUS KOUSA	KOUSA DOGWOOD	5	11	69	ONSITE	REMOVE	
	9741	ACER SACCHARINUM	SILVER MAPLE	13	40	69	ONSITE	REMOVE	SEVERE LEAN OVER EXISTING BUILDING.
	9742	ACER SACCHARINUM	SILVER MAPLE	12	12	69	ONSITE	REMOVE	FUNGAL FRUITING BODIES GROWING ON ROOT FLARE. DECAY PRESENT IN ROOT FLARE.
		ACER SACCHARINUM	SILVER MAPLE	15	35	75	ONSITE	REMOVE	
	9744	ACER SACCHARINUM	SILVER MAPLE	11	12	69	ONSITE	REMOVE	SIGNIFICANT EPICORMIC GROWTH ON TRUNK.
	9745	ACER SACCHARINUM	SILVER MAPLE	9	17	66	ONSITE	REMOVE	SIGNIFICANT POISON IVY GROWTH ON TRUNK AND INTO CANOPY. HEAVY LEAN.
	9746	LIRIODENDRON TULIPIFERA	TULIP POPLAR	19	15	75	ONSITE	REMOVE	
	9747	LIRIODENDRON TULIPIFERA	TULIP POPLAR	27	28	66	ONSITE	REMOVE	ROOTS ARE HIGHLY ERODED. OLD WOUND EXPOSING DECAY. OLD WOUND HAS CREATED WEEPING CANKER.
	9748	ACER RUBRUM	RED MAPLE	8	9	75	ONSITE	REMOVE	
		FAGUS GRANDFOLIA	AMERICAN BEECH	9	20	69	ONSITE	REMOVE	OLD TRUNK ON TOP OF ROOT FLARE.
	9750	FAGUS GRANDFOLIA	AMERICAN BEECH	8	17	75	ONSITE	REMOVE	
	9751	ILEX OPACA	AMERICAN HOLLY	7	8	75	ONSITE	REMOVE	
	9752	FAGUS GRANDFOLIA	AMERICAN BEECH	8	12	75	ONSITE	REMOVE	
	9753	FAGUS GRANDFOLIA	AMERICAN BEECH	8	14	75	ONSITE	REMOVE	
	9754	ACER RUBRUM	RED MAPLE	22	34	72	ONSITE	REMOVE	
	9755	LIRIODENDRON TULIPIFERA	TULIP POPLAR	30	27	72	ONSITE	REMOVE	DEAD SCAFFOLD BRANCHES. SIGNIFICANT ENGLISH IVY ON TRUNK.
	9756	LIRIODENDRON TULIPIFERA	TULIP POPLAR	34	36	69	ONSITE	REMOVE	SIGNIFICANT ENGLISH IVY ON TRUNK. CURVE IN TRUNK BASE.
С	9757 9758	LIRIODENDRON TULIPIFERA CORNUS FLORIDA	TULIP POPLAR FLOWERING DOGWOOD	8	18	69	ONSITE	REMOVE	DOUBLE TRUNK. THIRD TRUNK REMOVED. ROT POCKET IN TRUNK DUE TO REMOVED BRANCH. ROT POCKET IN SECOND TRUNK DUE TO TEAR OUT. FEW
	9759	MALUS SPP.	CRABAPPLE	12	22	63	ONSITE	REMOVE	WOUNDS IN TRUNK. SIGNIFICANT SAPSUCKER HOLES ON TRUNK AND ALL BRANCHES. MECHANICAL
	9760	PRUNUS SEROTINA	BLACK CHERRY	10	12	63	ONSITE	REMOVE	DAMAGE TO ROOT. ROT IN TRUNK FROM DEAD SECONDARY TRUNK REMOVAL OTHER WOUNDS IN TRUNK. SIGNIFICANT ENGLISH IVY ON TRUNK. MANY SMALL BRANCHES, NOT MANY LARGE SCAFFOLD BRANCHES.
	9761	LIRIODENDRON TULIPIFERA	TULIP POPLAR	24	18	72	ONSITE	REMAIN	SIGNIFICANT ENGLISH IVY ON TRUNK.
		LIRIODENDRON TULIPIFERA	TULIP POPLAR	29	38	72	ONSITE	REMAIN	SIGNIFICANT ENGLISH IVY ON TRUNK.
		LIRIODENDRON TULIPIFERA	TULIP POPLAR	5	12	72	ONSITE	REMAIN	SIGNIFICANT ENGLISH IVT ON TRONK.
	9764	ACER SACCHARUM	SUGAR MAPLE	22	21	66	ONSITE	REMAIN	DEAD TRUNK ATTACHED.
		LIRIODENDRON TULIPIFERA	TULIP POPLAR	11	16	72	ONSITE	REMAIN	CAVITY IN TRUNK.
		ACER RUBRUM	RED MAPLE	9	25	69	ONSITE	REMAIN	
	9767	LIRIODENDRON TULIPIFERA	TULIP POPLAR	11	22	69	ONSITE	REMAIN	
	9768	LIRIODENDRON TULIPIFERA	TULIP POPLAR	21	47	63	ONSITE	REMOVE	WOUNDS IN TRUNK, LARGE TORN-OFF BRANCH ON TRUNK, TRUNK IS TWISTY AND UNEVEN.
	9769	LIRIODENDRON TULIPIFERA	TULIP POPLAR	19	21	69	ONSITE	REMOVE	TWISTY TRUNK.
		UNIDENTIFIED	DEAD TREE	7	2	25	ONSITE	REMOVE	DEAD TREE.
		ROBINIA PSEUDOACACIA	BLACK LOCUST	7	24	69	ONSITE	REMOVE	
	9772	ROBINIA PSEUDOACACIA	BLACK LOCUST	8	16	72	ONSITE	REMOVE	
	9773	ROBINIA PSEUDOACACIA	BLACK LOCUST	12	18	72	ONSITE	REMOVE	
	9774	ROBINIA PSEUDOACACIA	BLACK LOCUST	12	14	69	ONSITE	REMOVE	TRUNK SEVERELY RUBBING TREE 9774.
	9775	ROBINIA PSEUDOACACIA	BLACK LOCUST	9	28	66	ONSITE	REMOVE	TRUNK SEVERELY RUBBING TREE 9774. HAS HEAVY LEAN TOWARDS ADJACENT BACKYARD.
		SASSAFRAS ALBIDUM	SASSAFRAS	13	23	75	ONSITE	REMOVE	
	9777	FAGUS GRANDFOLIA	AMERICAN BEECH	24	28	75	ONSITE	REMOVE	
		FAGUS GRANDFOLIA	AMERICAN BEECH	7	15	72	ONSITE	REMOVE	SMALL WOUND ON TRUNK. ROOTS EXPOSED.
		LIRIODENDRON TULIPIFERA	TULIP POPLAR	15	30	72	ONSITE	REMOVE	SOME EXPOSED ROOTS.
в	9780	FAGUS GRANDFOLIA	AMERICAN BEECH	5	12	75	ONSITE	REMOVE	SMALL WOUND ON TRUNK.
٦	9782	FAGUS GRANDFOLIA	AMERICAN BEECH	12	19	66	ONSITE	REMOVE	GROWING DIRECTLY INTO ADJACENT DEAD TREE TRUNK.
	9783 9784	SASSAFRAS ALBIDUM FAGUS GRANDFOLIA	SASSAFRAS AMERICAN BEECH	6	16 12	72	ONSITE	REMOVE	ALMOST ENTIRELY DEAD. WEEPING WOUND IN TRUNK. ROT IN TRUNK. MULTIPLE WOUNDS ON MULTIPLE BRANCHES. CANOPY OF TREE 9785 LAYING IN
	9785	DRUMUS SEROTINA	BLACK CHEBOY	-	17	60	ONICITE	DENADUE	CANOPY OF TREE 9784.
	9785	PRUNUS SEROTINA	BLACK CHERRY BLACK CHERRY	8		66	ONSITE	REMOVE	LEAN IN TRUNK. EXTREMELY UNEVEN CANOPY. EXTREME LEAN, ROT IN TRUNK.
		PRUNUS SEROTINA		7	19	63			
	9787 9788	CARYA GLABRA LIRIODENDRON TULIPIFERA	PIGNUT HICKORY TULIP POPLAR	6 28	11 32	72	ONSITE	REMOVE	INCLUDED BARK AT TOP OF TREE. ROT IN ROOT FLARE.
		FAGUS GRANDFOLIA	AMERICAN BEECH	6	14	75	ONSITE	REMOVE	NOT IN NOOT FLANE.
		FAGUS GRANDFOLIA	AMERICAN BEECH	7	12	75	ONSITE	REMOVE	
	0701	HEY OBACA	AMERICAN DEECH	<u> </u>	42		OFFICITE	REMOVE	DUAL TRUNKS. INCLUDED BARK AND SMALL CAVITY IN UNION. SOME SCAFFOLD

DUAL TRUNKS. INCLUDED BARK AND SMALL CAVITY IN UNION. SOME SCAFFOLD BRANCHES GROWING TOGETHER WITH INCLUDED BARK.

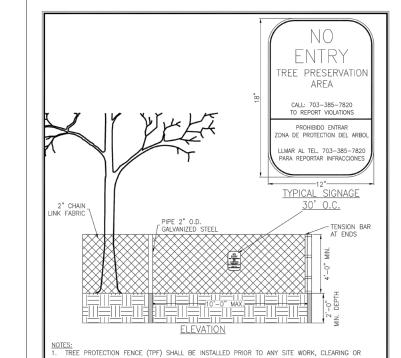

NOTES:

1. TREE PROTECTION FENCE (TPF) SHALL BE INSTALLED PRIOR TO ANY SITE WORK, CLEARING OR DEMOLITION. THE CITY OF FAIRFAX SHALL BE NOTIFIED 72 HOURS PRIOR TO INSTALLATION OR ANY OTHER TREE PRESERVATION MEASURE SPECIFIED IN PLANS AND SHALL APPROVE LAYOUT.

2. NO PERSONNEL, VEHICLES, EQUIPMENT, CONSTRUCTION MATERIALS OR DEBRIS ALLOWED IN TREE PROTECTION AREAS WITHOUT WRITTEN CONSENT FROM THE CITY OF FAIRFAX.

3. REMOVE TPF ONLY WITH APPROVAL FROM THE CITY OF FAIRFAX AFTER ALL SITE WORK HAS BEEN COMPLETED.


Department of Public Works
10455 Armstrong Street
Fairfax, VA 22030-3630
USE WITH THE FAIRFAX STANDARD SPECIFICATIONS ONLY www.foirfovvo STANDARD TREE PROTECTION FENCE INSTALLATION


- The requirements of the City of Fairfax Zoning Ordinance and Public Facilities Manual shall be followed. No changes shall be made to tree conservation unless directed or approved by Fairfax City Urban
 - All tree conservation activities shall be performed under the direct supervision of an ISA Certified Arborist and follow most recent ANSI standards for tree care.
 - Prior to the pre-construction meeting, the contractor shall have the limits of clearing and grading clearly marked in the field with flagging. These limits shall not exceed those shown on the approved
 - Prior to installation of erosion and sediment controls, grading, demolition, or other disturbance, including tree removal, a pre-construction meeting shall be held with Fairfax City Urban Forester. Changes to the plan, based on field conditions, may be requested by the Urban Forester at the time
- Removal of trees, noted for removal on the plan, inside a tree preservation area shall be performed, by hand, without ground disturbance, or disturbance to nearby preserved trees. Trees in these areas shall be cut flush to the ground, without stump grinding. If stump grinding is necessary then approval
- All pruning shall be in accordance to most recent ANSI standards for tree care. Any tree maintenance not in accordance with these standards may be a violation of the zoning ordinance. If additional pruning is needed to meet clearance standards for rights of way approval by Fairfax City Urban
- No person shall remove or destroy any tree which is five (5) inches or greater at standard height (4.5 feet from base of ground), on any residential zone lot greater than one-half acre and in all other zoned districts without first obtaining a tree removal permit from the zoning administrator. Any tree removed, damaged or destroyed will be replaced at the discretion of the zoning administrator. The contractor shall not disturb and shall protect all trees and shrubs outside of construction limits,
- including trees on other properties, or rights-of-way.

 Tree protection areas shall have all non-native invasive vines removed at the end of the project. An invasive management plan shall be provided when deemed necessary by Fairfax City Urban Forester or per the approved plan to ensure tree survival. Tree protection area shall be covered with shredded
- hardwood mulch, or other organic mulch as approved by Fairfax City Urban Forester.

 Any substitutions or changes to the approved landscape plan shall be requested and approved by Fairfax City Urban Forester prior to installation.

 All planting materials and work shall comply with recommendations and requirements of most recent
- ANSI standards for nursery stock and per the approved plan. Any material below this standard will not be accepted and will require replacement.
- Installation of plants shall be within Fairfax City's approved planting seasons approximately March-May or September-December during unfrozen soil conditions. Planting outside these seasons require approval by Fairfax City Urban Forester prior to installation. All material shall be installed within 72 hours from delivery to the project site. An inspection of materials by Fairfax City Urban Forester may be requested with minimum five (5) days notice prior to installation.
- At the end of the project, conserved and planted trees must be inspected and approved by Fairfax City Urban Forester. Changes to the plan, based on field conditions, may be requested by the Urban

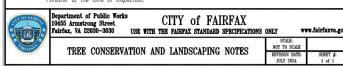

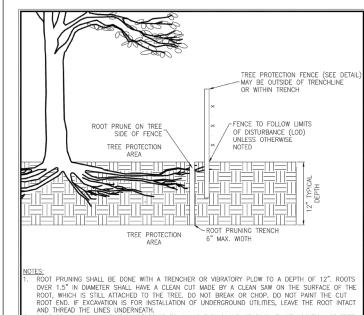

ROOT END. IF EXCAVATION IS TOR INSTALLATION OF UNDERGROUND UTILITIES, LEAVE THE ROOT INTACT AND THREAD THE LINES UNDERNEATH.

ROOT PRUNING SHALL TAKE PLACE PRIOR TO ANY CLEARING AND GRADING. EXACT LOCATION OF TREE PROTECTION AREAS SHALL BE STAKED OR FLAGGED PRIOR TO TRENCHING AND SHALL BE APPROVED BY THE CITY OF FAIRFAX.

EXACT ROOT PRUNING LOCATION TO BE DETERMINED AND SUPERVISED BY AN ISA CERTIFIED ARBORIST.

BACKFILL THE ROOT—PRUNING TRENCH WITH APPROVED LOOSE TOPSOIL MIX AND TOP WITH 3"-4"

BARK MULCH AND MARK LOCATION FOR FUTURE REFERENCE, SILT FERCE MAY BE INSTALLED IN TRENCH PRIOR TO BACKFILLING AS LONG AS THE TRENCH IS NOT OPEN FOR LONGER THAN 48 HOUR WITHOUT WATERING.

WINDOUT WALEKING.
ROOT PRUNING WORK SHALL NOT BE DONE WHEN MORE THAN THE TOP 1" OF SOIL IS FROZEN. ROO
PRUNING SHALL NOT BE UNDERTAKEN WHEN THE SOIL IS WET AND CONDITIONS ARE MUDDY.
THE CITY OF FAIRFAX SHALL BE NOTIFIED 72 HOURS PRIOR TO TRENCHING AND WHEN ALL ROOT
PRUNING AND TREE PROTECTION FENCE INSTALLATION IS COMPLETE.

Department of Public Works

	10455 Armstrong Street Fairfax, VA 22030-3630	USE WITH THE FAIRFAX STANDARD SPECIFICATIONS	ONLY W	ww.fairfaxva.go
TANK TO	שמעת שמעת	ECTION WITH ROOT PRUNING	SCALE: NOT TO SCALE	TP-02
	IREE PROI	ECTION WITH ROOT PROBING	REVISION DATE: JULY 2024	SHEET #: 1 of 1



TP-01

SHEET #:

GENERAL NOTES:

- CONTRACTOR IS RESPONSIBLE FOR CONTACTING MISS UTILITY PRIOR TO BEGINNING ANY WORK
- ALL CONSTRUCTION ACTIVITY BEYOND THE LIMITS OF CLEARING AND GRADING SHOWN WITHIN THIS PLAN SET SHALL BE PROHIBITED UNLESS PREVIOUSLY APPROVED BY THE CITY OF FAIRFAX.
- ANY TREES REQUIRED TO BE CLEARED OUTSIDE OF THE LIMITS OF DISTURBANCE MAY ONLY BE CLEARED BY





ADVANCE COPY **NOT FOR** CONSTRUCTION

HIGHLANDS AT MANTUA GENERAL DEVELOPMENT PLAN AMENDMENT MASTER DEVELOPMENT PLAN & ZONING MAP AMENDMENT CITY OF FAIRFAX, VA

4 ADDRESSED PER CITY COMMENTS	ADDRESSED PER CITY COMMENTS								DESCRIPTION	
09-27-2024	01-06-2025	06-04-2025							DATE	
1	2	3							MARK	
PR	PROJECT No.: 23005060.00									


ATE: 2025-05-23 SCALE: NOT TO SCALE DESIGN: AH, QN DRAWN: AH, QN CHECKED: JM

HEET TITLE:

TREE **PRESERVATION** PLAN NOTES AND DETAILS

SHEET No

C203

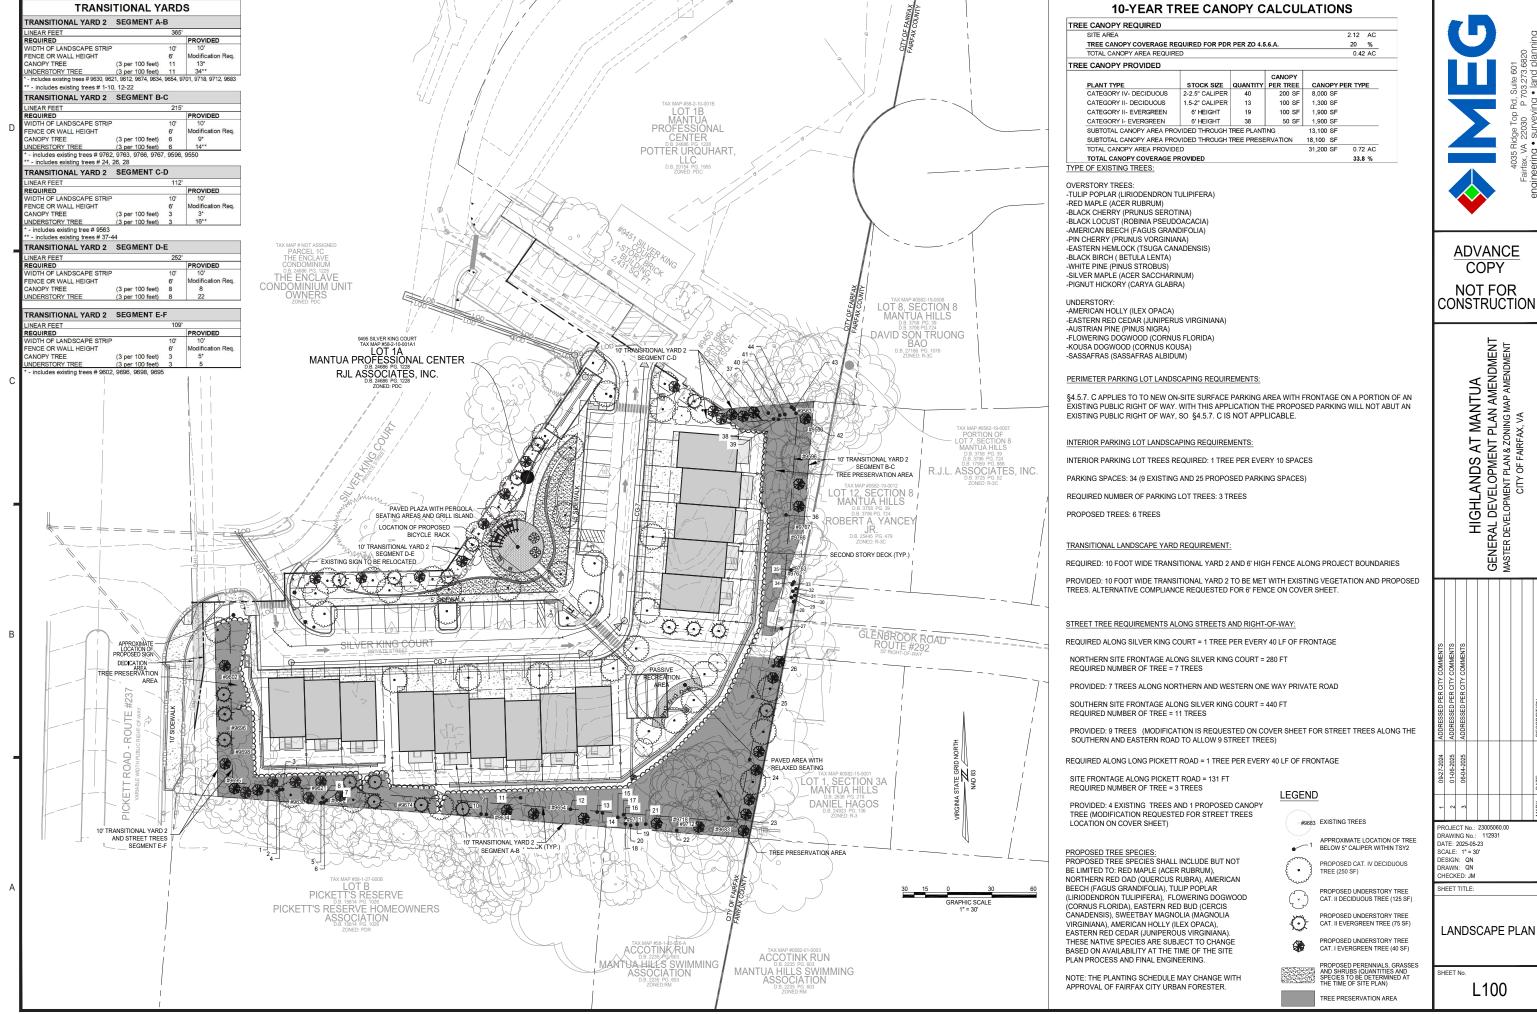

Sheet 22



Red Maple acer rubrum



quercus rubra

magnolia virginiana



Duraheat River Birch betula nigra 'duraheat'



Willow Oak quercus phellos



American Beech fagus grandifolia



Eastern Redbud cercis canadensis



Flowering Dogwood cornus florida



American Holly ilex opaca



Eastern Redcedar juniperus virginiana



Gro-low Fragrant Sumac rhus aromatica 'gro-low'



Dwarf Redosier Dogwood cornus sericea 'kelseyi'



Cherry Laurel prunus laurocerasus 'Otto Luyken'



Evergreen Giant Liriope liriope muscari 'evergreen gaint'



Black-eyed Susan rudbeckia fulgida

Date: 07-07-2025



time of site plan.



BIKE RACK - OLYMPIA

MAKE: FORMS+SURFACES

MODEL#: SKOLY

COLOR:

MATERIAL: ALUMINUM FINISH: **POWDERCOAT**

OR EQUAL

SILVER TEXTURE



BENCH - CAMBER

MAKE: FORMS+SURFACES

SBCAM-72BW MODEL#:

ALUMINUM MATERIAL: POWDERCOAT FINISH:

COLOR: SILVER TEXTURE

OR EQUAL



GRILL ISLAND (1) GRILL, GRANITE CONTERTOP, **BRICK VENEER**



TRASH RECEPTACLE - APEX

MAKE: FORMS+SURFACES

MODEL#: SLAPX-136C MATERIAL: **ALUMINUM** FINISH: **POWDERCOAT**

COLOR:

OR EQUAL

SILVER TEXTURE



SEATING W/SHADE - TANGENT TABLE

FORMS+SURFACES MAKE:

SETAN-4BA,4BW,4BS MODEL#: ALUMINUM MATERIAL: FINISH: **POWDERCOAT** COLOR: SILVER TEXTURE



OR EQUAL

PERGOLA MATERIAL AND COLOR: TBD



RELAXED SEATING

ADIRONDACK CHAIRS, ROUND SIDE TABLE

MAKE: POLYWOOD OR EQUAL

COLOR: TBD



RETAINING WALL

STRUCTURAL RETAINING WALL MAKE: YORK BUILDING PRODUCTS MODEL: CONERSTONE 100 NEW HOLLAND

COLOR: FIELDSTONE



SAFETY FENCE ALUMINUM WITH POWDER COAT FINISH COLOR: BLACK



PAVED AREA - PAVERS

MAKE: **HANOVER** MODEL#: PREST PAVERS

FINISH: TUDOR

COLOR: CHARCOAL, NATURAL,

LIMESTONE GRAY

NOTE: FINAL PAVING PATTERN TO INCLUDE ALL THREE COLORS LISTED ABOVE. (FINAL PATTERN TO BE PROVIDED AT THE TIME OF SITE PLAN)



CROSSWALK WHITE 'LADDER-STYLE' CROSSWALKS, AS SHOWN



PRIVACY FENCE BOARD-ON-BOARD PRESSURE-TREATED WOOD

SITE FURNISHINGS / HARDSCAPE SELECTIONS





LIGHTING SCHEDULE

POLE LIGHT

PATH LIGHT

DOWNLIGHT AT PERGOLA



LIGHTING PLAN









The Hadco Baltimore LED post top consists of a traditional stately form that has created an industry standard. It offers the style of traditional lanterns with today's cutting edge LEDgine technology. For historic areas and new streetscapes Baltimore is available in sizes that are in proportion to most applications including residential streets, city streets, campuses and parking lots.

Project:	
Location:	
Cat.No:	
Type:	
Lamps:	Qty:
Notes:	


Ordering guide

Example: VX681-48-G3-A-C-2-N-N-730-A-3-N-SP1

Series VX681	LED count	Gen G3	Finish	Panels	Distribution	Photocontrol Rec	eptacle
X681	32 32 LEDs 12 48 48 LEDs 1 64 64 LEDs 80 80 LEDs	G3 Gen 3	A Black B White G Verde H Bronze J Green	C Clear F Frosted V Vertical Ribbed	2 Type 2 2H Type 2 w/ HSS 3 Type 3 3H Type 3 w/ HSS 3W Type 3 Wide 3WH Type 3 Wide w/ HSS 4 Type 4 5 Type 5	N None E 120 VAC button H 208/240/277 V/ R 3-Pin Twist Loc	AC button eye
Future-Proof Receptacle	Color Temp	Voltage	Drive Current	Driver Options			Surge Protection
R7 7-pin receptacle in cage N None	730 Warm 3000K 740 Neutral 4000K	A 120-277 B 347-480 ²	3 350mA ² 5 530mA 7 700mA ¹	Dynadimmer DA' 4 Hrs, 25% redu DB' 4 Hrs, 50% redu DD' 6 Hrs, 25% redu DB' 6 Hrs, 50% rede DB' 6 Hrs, 75% redu DB' 6 Hrs, 75% redu DB' 8 Hrs, 25% red DB' 8 Hrs, 50% red DJ' 8 Hrs, 75% redu	DL¹ DALI section S FAWS section SRD³ Sense (stank stank stan	Field Adjustable ge Selector or ready driver dard configuration) or ready driver nate configuration)	SP1 10kV/10kA Surge Protector SP2 20kV/20kA Surge Protector

- 1. The 700mA (7) current is only compatible for 32 LEDs (32) and 48 LEDs (48) configurations.
- 2. Configurations with 347-480V (B) voltage are not compatible with 32 LEDs (32) at 350mA (3) 3. Only available with 120-277V (A) voltage

Dimensions

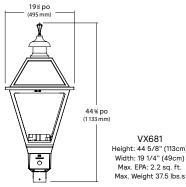

Height: 44 5/8" (113cm) Width: 19 1/4" (49cm)

Baltimore-LED-VX681spec 09/22 page 1 of 5



PATH LIGHT

12V Two Arm Path Light


15844



FEATURES

- Thick, robust cast construction
- Textured diffusion lens for glare control and uniform light spread
- · No visible seams or screws
- Optimized socket location, easy to lamp



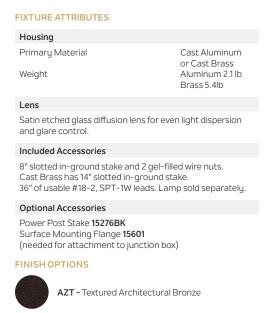



BKT - Textured Black



CBR - Centennial Brass



LIGHTING SPECIFICATIONS





VLO 12V LED Large Accent

Additional Specs



FINISH OPTIONS



AZT - Textured Architectural Bronze



BKT - Textured Black



CBR - Centennial Brass

PERFORMANCE

Output Position	Level 1	Level 2	Level 3
Lumen Output	400 lm	600 lm	835 lm
Input Voltage	9V-15V	9V-15V	9V-15V
Power (VA) @ 15V AC	8.5VA	12.5VA	17VA
Power (W) @ 15V DC	5.25W	8.5W	12W
Efficacy (Im/W @ DC)	76 lm/W	70 lm/W	69 lm/W
Halogen Equivalents	40W	60W	83.5W

SPECIFICATIONS

Fixture

Light Source Integrated LED Number of LEDs 1 High Output COB Color Temperature 2700K, 3000K Color Rendering Index 15°, 35°, 60° Beam Angles Binning 3 Step

Fixture can be used in up or down position.

Input

Power Factor

Input Voltage Range 9 – 15V AC or DC with no loss in light output 47 - 63Hz Input Frequency 2.55A Max @ 9VAC Input Current Inrush Current 9A Max > 70L/W @ 12VDC Efficiency

Environmental Protection Rating Wet, IP66 Operation Ambient Temperature -25°C - +40°C 50K Hours Lumen Maintenance (L70)

Mechanical & Housing Specification

Diameter/Height 2.75" W x 6" L x 4.5" H Housing Material Cast Aluminum, Cast Brass Housing Color & Surface AZT, BKT or CBR 24 oz (Aluminum), 48 oz (Brass) Weight

Lens Material

Tempered, shock resistance glass with high tolerance for

Wire

18 AWG, 105°C, 300V 48" of usable #18-2 SPT-1W leads.

Optics

Custom reflector provide uniform center-to-edge light distribution. Available in a 15, 35 and 60 degree beam angles.

FIXTURE ATTRIBUTES

Included Accessories

8" Slotted In-ground Stake, 2 Gel-Filled Wire Nuts, Locknut, and Magnetic Key.

Optional Accessories


3" Riser Stem 15509CBR 15645AZT, BKT, 15510CBR 15656AZT, BKT, 15511CBR 6" Riser Stem 12" Riser Stem 18" Riser Stem 15657AZT, BKT, 15512CBR 24" Riser Stem 15658AZT, BKT, 15513CBR Adjustable Riser Stem 15570AZT, BKT 15649AZT, BKT 15493CBR Stem Coupler Mounting Base Two Fixture "T" 15515CBR Surface Flange 15601AZT, BKT 15607AZT, BKT, 15516CBR 15609AZT, BKT, CBR 15647AZT, 15514CBR Tree Mount Elbow Gutter Mount 15489CBR Long Cowl 16068CBR Amber Lens 16072AMB Green Lens 16072GRN 16075BK Hexcell Louver Beam Expander 16091FRO 15575BK 8" Stake 14" Stake 15576BK Power Post 15276BK

LOAD CHART

Powe	er	Wire Gauge / Length (ft/m) Load Chart								
(VA)	10 AWG	12 AWG	14 AWG	16 AWG					
0-20	VA	1860'/567 m	1150'/351 m	730'/223 m	450'/137 m					
40 V	A	930'/283 m	580'/177 m	370'/113 m	230'/70 m					
60 V	A	620'/189 m	390'/119 m	240'/73 m	150'/46 m					
80 V	A	470'/143 m	290'/88 m	180'/55 m	110'/34 m					
100 V	Ά	370'/113 m	230'/70 m	140'/43 m	90'/27 m					
>100 \	/A	Consult Technical Support								



DOWNLIGHT AT PERGOLA

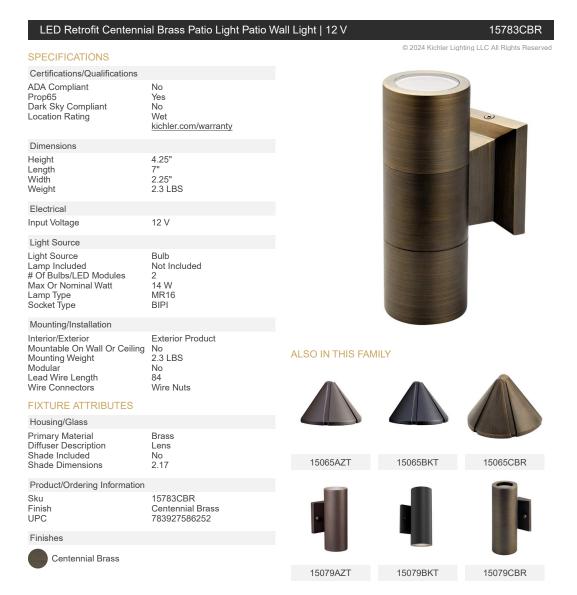

KICHLER.

LIGHTING SPECIFICATIONS



